



SCHEDULE OF DOORS & WINDOWS					
SL.NO.	TYPE	WIDTH	HEIGHT	NOS.	DESCRIPTION
1	D	1500	2100	6	Daboule panel wooden door
2	D1	1200	2100	20	Single panel wooden door
3	D2	750	2100	17	Single panel wooden door
4	W	1500	1200	22	Steel frame glazed window
5	W1	1200	1200	18	Steel frame glazed window
6	W2	1800	1200	8	Steel frame glazed window
7	V	600	600	17	Center hung steel frame glazed ventilator
8	V1	1200	600	12	Center hung steel frame glazed ventilator
9	F.G-1	1500	900	1	Fixed grill glazed window
10	F.G-1	1500	900	1	Fixed grill glazed window
10	BFG	3000	2400	2	BI FOLD GRILL

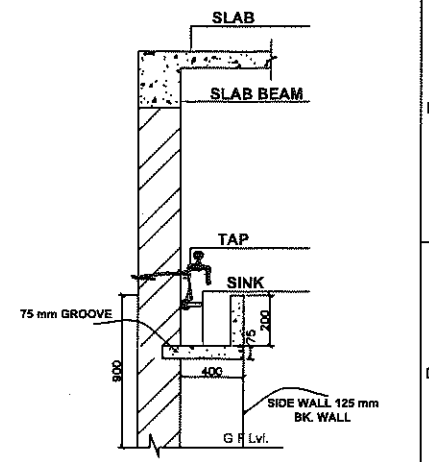


Pardeep Singh Sr. Arch.
 Revised for
 Drinking water point

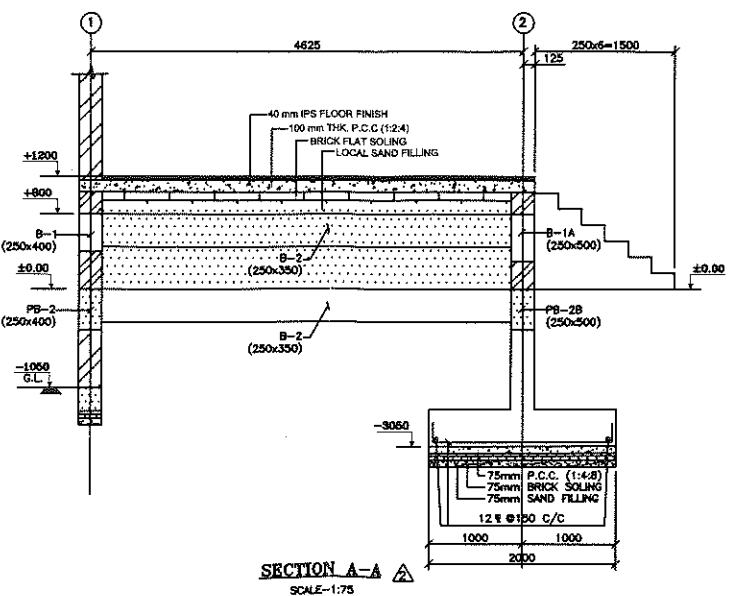

BIHAR STATE EDUCATIONAL INFRASTRUCTURE DEVELOPMENT CORPORATION LTD. SHIKSHA BHAWAN, SAIDPUR, PATNA		PROJECT	PROPOSED CONSTRUCTION OF INSTITUTIONAL BUILDING OF DIET
<i>Ayaz Khan 11-7-18</i> DRAUGHTSMAN BSEIDC, PATNA		DEPT.	BIHAR STATE EDUCATIONAL INFRASTRUCTURE DEVELOPMENT CORPORATION LTD. SHIKSHA BHAWAN, SAIDPUR, PATNA
<i>Pardeep Singh 11-7-18</i> SENIOR (ARCH.) BSEIDC, PATNA		ARCHT. AND CONSULTANT	RDCS RANCHI DESIGN & CONSULTANCY SERVICES PVT. LTD. SOUTH OFFICE PARA, NEAR ST.XAVIER SCHOOL DORANDA, RANCHI-834002
CHECKED & APPROVED DESIGN BY DRAWN BY SIZE-		S.L.GOPE S.A. PRADEEP	GROUND FLOOR PLAN DRG. NO.-RDCS/BSEIDC/0033/DIET/001 SHEET 1 OF 3 REV R=1

NOTES:-
 1. ALL DIMENSIONS AND LEVELS ARE IN mm. & FIGURED DIMENSIONS SHALL BE FOLLOWED.
 2. ±0.00 LEVEL CORRESPONDS TO PLINTH LEVEL(P.L.) OF BUILDING. WHICH IS 600mm ABOVE GROUND LEVEL(G.L.).
 3. ALL RCC WORK SHALL BE OF M25 GRADE CONCRETE.
 4. BRICKWORK SHALL BE WITH 100A BRICKS IN CEMENT MORTAR 1:6.


REV.	DESCRIPTION	DATE	BY

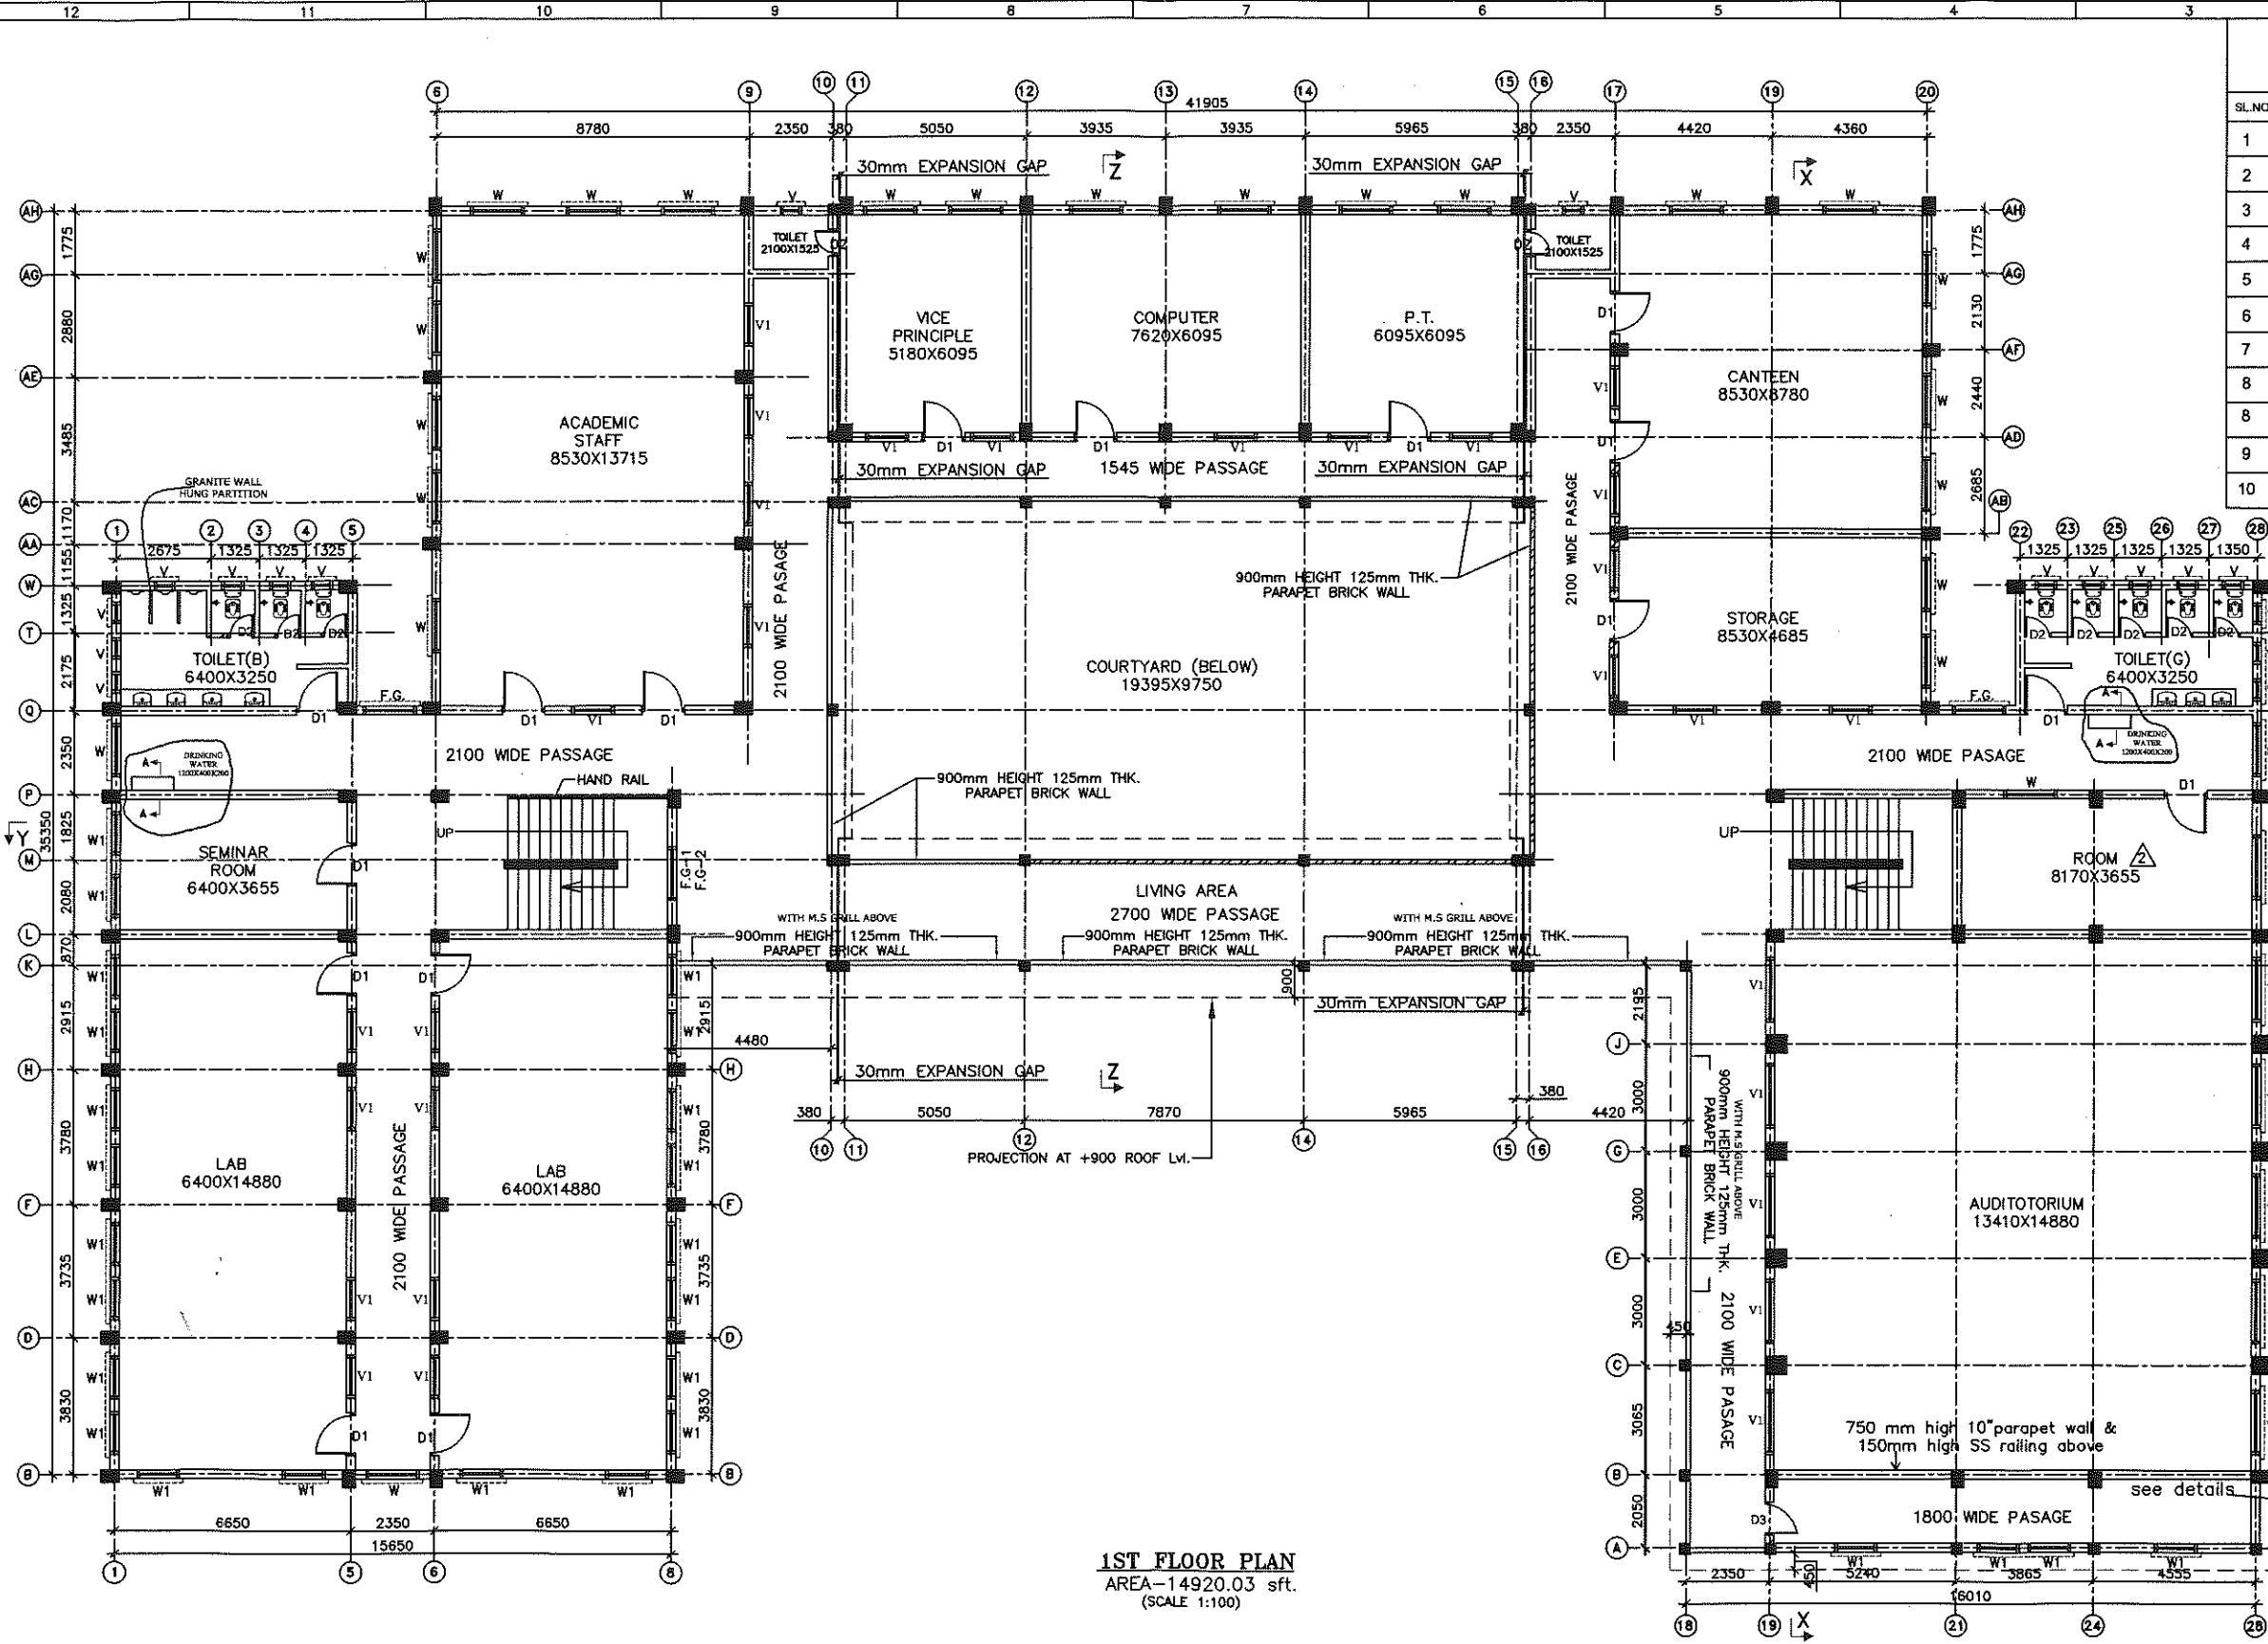


1ST FLOOR PLAN
 AREA-14920.03 sq.ft.
 (SCALE 1:100)

SCHEDULE OF DOORS & WINDOWS


SL.NO.	TYPE	WIDTH	HEIGHT	NOS.	DESCRIPTION
1	D1	1200	2100	16	Single panel wooden door
2	D2	750	2100	10	Single panel wooden door
3	D3	900	2100	1	Single panel wooden door
4	W	1500	1200	24	Steel frame glazed window
5	W1	1200	1200	22	Steel frame glazed window
6	W2	1800	1200	1	Steel frame glazed window
7	V	600	600	16	Center hung steel frame glazed ventilator
8	V1	1200	600	32	Center hung steel frame glazed ventilator
8	F.G	1500	1200	3	Fixed grill glazed window
9	F.G-1	1500	900	1	Fixed grill glazed window
10	F.G-2	1500	600	1	Fixed grill glazed window

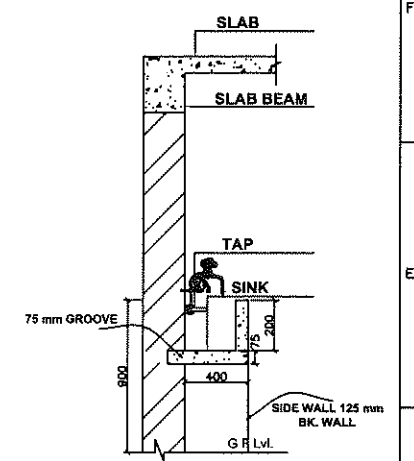

SECTION A - A

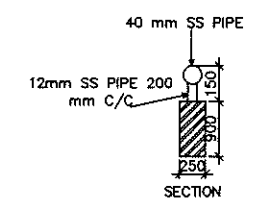

SECTION

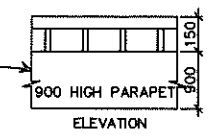

ELEVATION

Revised for drinking water point

BIHAR STATE EDUCATIONAL INFRASTRUCTURE DEVELOPMENT CORPORATION LTD.
 SHIKSHA BHAWAN, SAIDPUR, PATNA

PROJECT PROPOSED CONSTRUCTION OF INSTITUTIONAL BUILDING OF DIET

A. Hoque 11.7.18
 DRAUGHTSMAN
 BSEIDC, PATNA

Pankaj Singh 11.7.18
 ARCH.
 BSEIDC, PATNA

Pankaj Singh 11.7.18
 SENIOR (ARCH.)
 BSEIDC, PATNA

DEPT. BIHAR STATE EDUCATIONAL INFRASTRUCTURE DEVELOPMENT CORPORATION LTD.
 SHIKSHA BHAWAN, SAIDPUR, PATNA

ARCHT. AND CONSULTANT RANCHI DESIGN & CONSULTANCY SERVICES PVT. LTD.
 SOUTH OFFICE PARA, NEAR ST.XAVIER SCHOOL DORANDA, RANCHI-834002

- NOTES:-**
- ALL DIMENSIONS AND LEVELS ARE IN mm. & FIGURED DIMENSIONS SHALL BE FOLLOWED.
 - ±0.00 LEVEL CORRESPONDS TO PLINTH LEVEL(P.L.) OF BUILDING, WHICH IS 600mm ABOVE GROUND LEVEL(G.L.).
 - ALL RCC WORK SHALL BE OF M25 GRADE CONCRETE.
 - BRICKWORK SHALL BE WITH 100A BRICKS IN CEMENT MORTAR 1:6.

- CHECKED & APPROVED** S.L.GOPE
- DESIGN BY** S.A.
- DRAWN BY** PRADEEP
- SIZE-** SCALE 1:100

FIRST FLOOR PLAN

DRG. NO.-RDCS/BSEIDC/0033/DIET/001 SHEET 2 OF 3 REV R=2

REV.	DESCRIPTION	DATE	BY